


1 Overall Site Plan
C1 1"=80'



2 Locus
C1 1"=250'

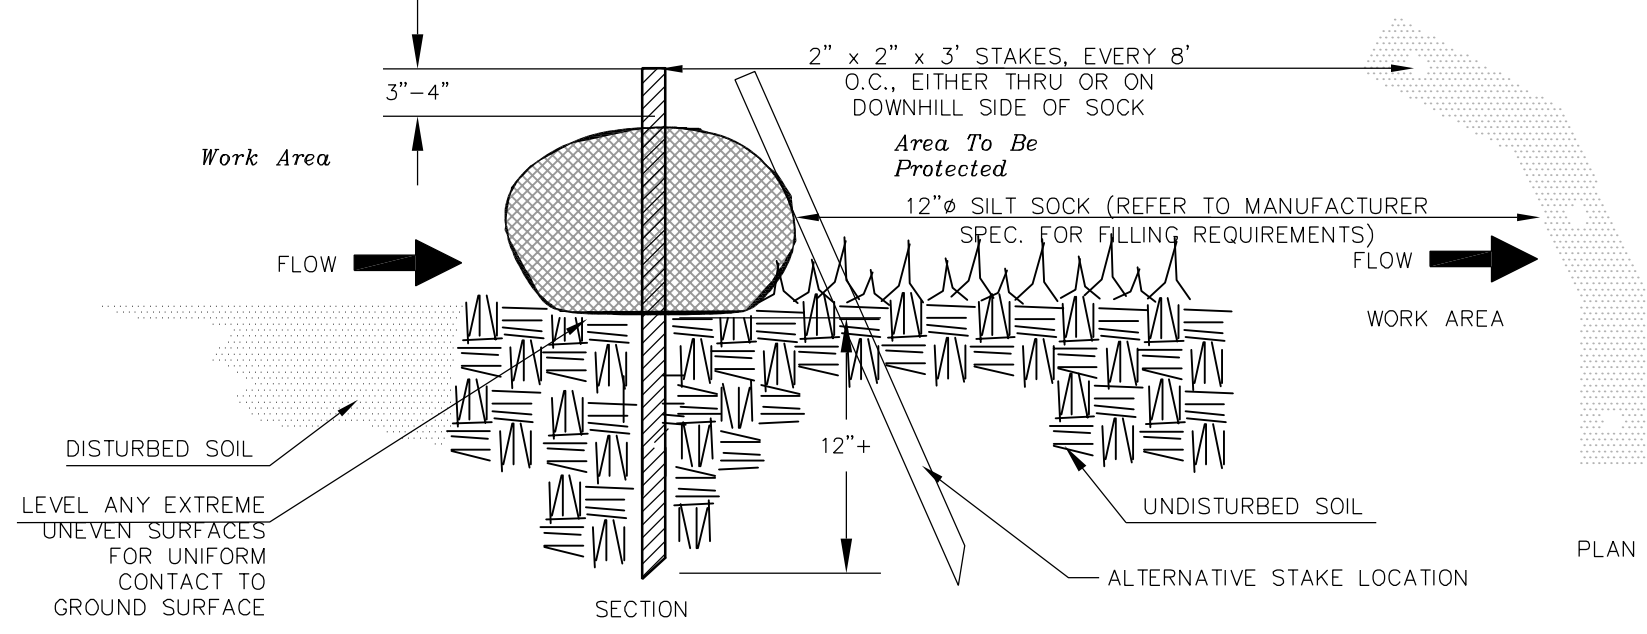


3 Erosion Control Barrier - Silt Sock Detail
C1 Not to Scale

Erosion Control Notes

1. Prior to beginning construction, erosion control barriers shall be installed downgradient of fill slopes in any areas where ground is being disturbed, including but not limited to bridge footings and boardwalk supports.
2. Erosion control barriers shall consist of silt socks placed tightly end to end, as shown on the detail above. An additional stockpile of erosion control materials is to be stored on-site in an area that allows retrieving erosion control materials readily obtainable. The amount of stored erosion control materials is not to be less than 15% of materials used for the entire project. Stored materials are to be made up of similar materials used during initial production.

Trail Plan		REVISIONS			
DRAWN BY:	AIC	DATE:	6.4.2021		
CHECKED BY:	CUL	DRAWING NO.:			
JOB NO.:		SCALE:	1"=80'	#	DESCRIPTION
				DATE	WHOM

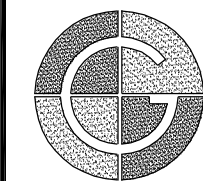

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Shelburne Falls Riverside Trail
PREPARED FOR
Shelburne Open Space Committee
Deerfield Ave Shelburne Falls, MA

C1